HARVARD TOTAL COM

2021 SEP 29 PM 12: 22

### HARVARD HISTORICAL COMMISSION

13 AYER ROAD • HARVARD, MASSACHUSETTS 01451

### APPLICATION FOR CERTIFICATE

Please read attached instructions and contact a member of the Harvard Historical Commission before you complete this form.

CERTIFICATE OF:	☐ X APPROPRIATENESS	□ NON-
APPLICABILITY	HARDSHIP	
CONTACT INFORMAT	ION:	
Property Address	13 Old Littleton Road, Harvard, MA 01451	
Property Owner Name	Anne Butterfield	
Applicant Name	Anne Butterfield	
Applicant Address	13 Old Littleton Road, Harvard, MA 01451	
Telephone	978-456-3933	
E-Mail Address	Anne@AnneButterfieldCompany.com	

**DESCRIPTION OF WORK PROPOSED:** (You may attach additional pages to describe your proposed work) If project consists of several different tasks, begin by listing each task, then describe each task in detail including drawings, plans, and photos as necessary. You may attach additional pages to describe your proposed work.

There was a deck/balcony across the back of the house at one time. It is not there now. I will re-open the door from the original door from the barn onto a new deck that will run behind the back of

the house. The deck will not extend to the back edge of the house on the eastern end.

The deck will not be seen driving or walking east from the town center, because the bay to the west was

built to hold the town's first school bus and is many feet longer that the east bay. It will not be visible

from Cross Street. During the winter, a portion of the deck will be visible for a few feet on Old Littleton

Road driving or walking west, toward the town center. A large specimen Rutgers Stellar Cornus (dogwood)

will screen the minimal view from Littleton Road and a Mimosa closer to the deck will further mask its

view. Plantings and trees on the east side of the property will effectively mask the deck 75% of the time.

Dimensions: 14' deep x 27' long x 7'8" high. A straight run staircase goes to the ground on the back

side of the deck. Preferred materials are: Timbertech Pro Reserve Groved for the flooring, Timbertech Railing and Timbertech Clips Hidden Fasteners; wood can be used if required.

LIST OF ATTACHMENTS: (Please check off the listed items when attached)

Site Plan (showing changes)	×	Construction Drawings	X
Photos taken from street	X	Building material samples	X
Photos of areas to be worked	X		

**APPLICANT SIGNATURE** (Sign to submit application)

anne Butterfuld

DATE

April 12, 2021

**GRANT OF EXTENSION.** (With the following signature, the applicant grants permission to the Commission to review the

application at its next scheduled monthly meeting in lieu of holding a Special meeting.)

Form: HHC

Application 5-1-2019

### INSTRUCTIONS: HHC APPLICATION FOR CERTIFICATE

### WHAT CHANGES REQUIRE THE APPROVAL OF THE HISTORICAL COMMISSION?

If your property is located in either of Harvard's Historic Districts, and you wish to modify any part or feature that is visible from a public way, you must first get the approval of the Harvard Historical Commission (HHC). Alterations include, but are not limited to, changing windows and doors, changing a paint color, new additions, partial or complete demolitions, new fences, new paved walkways, new steps, and adding solar panels. Approval is not required for any in-kind repairs, repainting the same color, interior changes or landscaping. For a complete list see the Harvard Historic District bylaw (Chap 48) or the HHC Design Guidelines on the HHC website. You may also ask for guidance from an HHC Advocate who will be assigned to you when you contact the HHC.

#### WHAT IS THE APPROVAL PROCESS?

#### SUBMIT AN APPLICATION

Download an application form from the HHC website, or get one from the Town Clerk. Complete and submit the application in triplicate (one for the Town Clerk, one for the HHC, and one for the Building Inspector). NOTE: The application process begins when you submit your completed Application (with any attachments) to the Town Clerk who will time-stamp the Application and notify the Historical Commission. In order to be considered complete, the application must include:

- Your name, address, and a detailed description of your project, and
- Pictures, scaled drawings and plans detailed enough to show the architectural design, examples of materials to be used, paint colors, and a plot plan (if applicable to the project).

If you submit your application during the two week period following the HHC monthly

meeting (usually the 1st Wednesday of the month), please check-off the "Grant of Extension" box to avoid having to call a Special Meeting. This will *not* extend the 60 day length of the overall decision process for your application.

 HHC DETERMINES WHETHER PROPOSED WORK MUST BE REVIEWED AND IF SO, WHETHER IT IS SUBSTANTIAL.

If your project is determined to be **non-applicable**, your application does not require formal review by the HHC and you will be granted a *Certificate of Non-Applicability* enabling you to proceed with your project.

If the project requires review, the HHC will determine at its next meeting whether your proposed work is a(n):

- Substantial change which requires HHC review and approval and a public hearing; or
- Insubstantial change that requires HHC review and approval, but not a public hearing.

If your application is determined to be **Substantial**, a hearing will be held at the next HHC meeting, and a legal notice will be published in the local newspaper at least 14 days before the hearing. You will be billed \$25 for an abutters list from the assessor's office and \$50 for the legal notice from the newspaper. A notice of the public hearing will be mailed to abutters, the Town Clerk, the Planning Board, and the Building Inspector. Please obtain an abutters' list with a 300 ft radius, in mailing label format, for a residential certificate and an all district abutters list fora commercial property.

If your application is determined to be **Insubstantial**, your application will be reviewed at the next HHC meeting without a public hearing. Notice will be mailed to abutters at least 10 days before the meeting, advising your neighbors that your application will be reviewed without public hearing unless a resident requests within the 10 day period that it be reviewed in a public hearing. If no requests for a public hearing are received, the Commission will proceed with a review without a public hearing during the next monthly meeting.

#### HHC REVIEWS and DECIDES

At its next meeting, HHC will review your application and related information and decide whether your proposal is:

- Approved -- HHC will issue a Certificate of Appropriateness which may include conditions, and is good for 2 years. A copy will be sent to you, the Town Clerk and the Building Inspector.
   You may proceed with the project.
- **Disapproved** HHC will state the reasons why it is inappropriate, and may describe what would be approved on a subsequent application. A copy will be sent to you, the Town Clerk and the Building Inspector. In some cases, HHC may make suggestions for changes that would make the application acceptable and give you 14 days to modify your application after which it will be approved. To pursue this option, you may need to request an extension to the 60-day limit mentioned below. In some cases, if your application is disapproved, HHC may consider granting you a hardship, see "What if I have a Hardship?" below.

### **HOW LONG DOES THIS PROCESS TAKE?**


It takes a maximum of 60 days, unless extended with your permission. HHC must get its decision to the Town Clerk within 60 days of the time you filed your completed application. If the HHC does not meet this deadline, they will send you a Certificate of Hardship for failure to act, and you can proceed with the project.

### WHAT IF I HAVE A HARDSHIP?

If your situation is so unusual that it would create a hardship if you were not allowed to proceed, then HHC may grant you a Certificate of Hardship if it feels your project is not a detriment to the public welfare, or substantially derogates the intent or purpose of the Historic District bylaw. An example of a hardship that might be allowed is if your building is visible on all four sides from a public way so that you have no place to make an alteration that may be inappropriate. If you wish to request a hardship, check the Hardship box on your application.

Note: This Q&A provides highlights of the HHC process in general. For added details, please refer to the Harvard Bylaw and the HHC Design Guidelines on the HHC website.

Form: HHC Application 5-1-2019

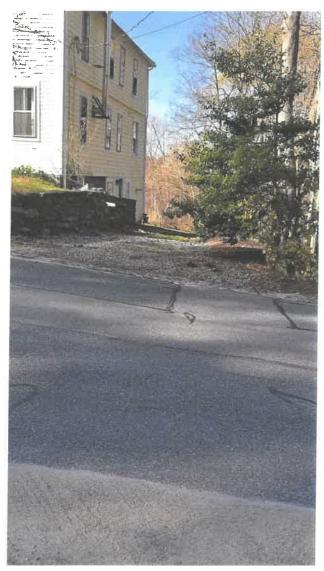


View from Cross Street. Deck will  $\underline{not}$  extend To end of building.



View of Old Littleton Road heading west (toward Town Center).

Deck is visible only in this view, will <u>not extend</u> to the full length of the far bay of the barn.

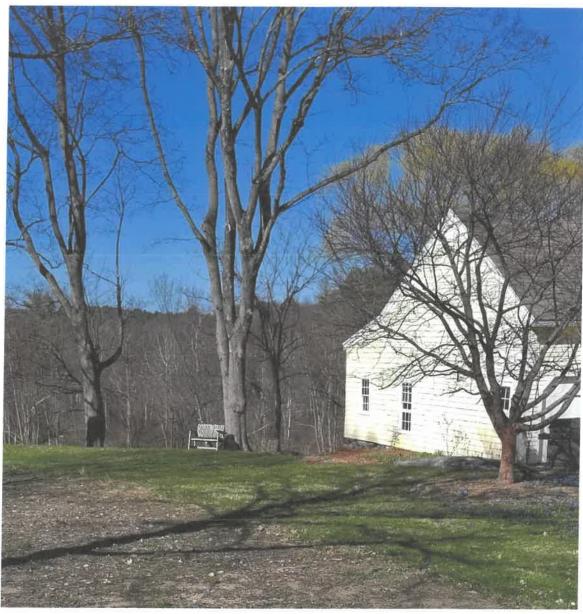

View from Old Littleton Road looking west (toward Town Center). The garage bay shown Completely blocks the view of the deck from this director.

Please find drawing of deck plan and requested material specs attatched.



Current Revision Sheet Name

A0-\_GENERAL A000A COVER

A001 GENERAL NOTES A020 SITE PLAN
A2-ELEVATIONS

A200 EXTERIOR ELEVATIONS

A4-DETAILS

A400

FRAMING PLANS AND DETAILS
DECK PLANS & DETAILS

### 13 OLD LITTLETON RD - NEW DECK

13 OLD LITTLETON RD, HARVARD, MA

07.19.2021

PROJECT TEAM

Sanjo Ramos 23 Golden Drive Stow, MA 01775 (508) 308-2000 sanjoramos@yahoo.com

[RE]Architect 166 Littleton Road Contact: Jamie Schwade (732)614-6584

CIVIL David E. Ross Associates, Inc.

6 Lancaster County Road - P.O. Box 795 -Harvard, MA 01451 (978) 772-6232

RE

NOT FOR CONSTRUCTION

**COVER** 

NEW DECK 13 OLD LITTLETON RD, HARVARD, MA 01451

PROJECT NUMBER

STATUS 07/19/21 TG CHECKED BY 2021.014

A000A

AFF AGGR GAUGE GALVANIZE ABOVE FINISHED FLOOR PAINTED AGGREGATE PRESSURE TREATED WOOD AL, ALUM ALLOW GL GYP PTW ALLOWANCE. GYPSUM GYPSUM WALL BOARD RADIUS, RISER, RUBBER ALTERNATE R RA ACOUSTICAL PANEL ASPHALT HD HEAD ASPH HDW HARDWARE RUBBER AVG **AVERAGE** HOR, HORIZ HORIZONTAL RECD RECEIVED RECEPTACLE BASE HEIGHT REFERENCE BBSP BLUEBOARD SKIM COAT PLASTER HOT WATER REF REFR REFRIGERATE IN INCL BD ROARD REG REINF REGISTER BETWEEN INCLUDE BLDG BO INFO INS INT JB JT REINFORCE INFORMATION REQD REQUIRED BY OTHERS INSULATE BRK CAB RET RM RETURN BRICK CARINET JUNCTION BOX SOUTH SCHEDULE C TO C CER CIP CJ CLNG CLR CMU CONC CONST CONT CTR CW DBT DIA DIM DR DR DR DWG CENTER TO CENTER JOINT S SCH CERAMIC LAMINATE LAVATORY SECTION CAST IN PLACE LB LIN SHT SHEET CONSTRUCTION JOINT LINEAR LOC LCC, LC LT MATL MAX SK SKETCH CENTERLINE LOCATION SEALED CEILING LEAD COATED COPPER SLR SEALER. CLEAR SLATE CONCRETE MASONRY UNIT MATERIAL SPECIFICATION MAXIMUM SQ SS STD STL SQUARE CONCRETE MET MEZZ MFG MIN MISC N NIC NOM NO NTS OA OBD OCD OFF OH OPP OPP CONSTRUCION CONTINUE MEZZANINE STANDARD MANUFACTURING STEEL CARPET MINIMIM STONE STRUCTIRAL CERAMIC TILE MISCELLANEOUS STR, STRUC CENTER NOT IN CONTRACT COLD WATER T&B TEL TEMP T&G TOP AND BOTTOM DOUBLE TELEPHONE DETAIL DIAMETER NUMBER TEMPERED NOT TO SCALE TONGUE AND GROOVE DIMENSION OVER-ALL THK OVERHEAD BIFOLD DOOR DOWN THROUGH TOS TP TYP OVERHEAD COILING DOOR TOP OF STEEL, TOP OF SLAB DRAIN DRAWING OUTSIDE DIAMETER TURNING POINT TYPICAL EAST V VB VCT VERT VEST VIF VP EL, ELEV **EXPANSION JOINT** OVER HEAD VAPOR BARRIER, VINYL BASE ELEVATION VINYL COMPOSITION TILE ELECTRIC OPPOSITE OVERHEAD VERTICAL. VESTIBULE EXH FOUIPMENT P PC PCF PERP EXHAUST PRECAST CONCRETE VERIFY IN FIELD VENEER PLASTER EXT FAC FD FDN POUNDS PER CUBIC FOOT PERPENDICULAR EXISTING WEST, WIDE FLANGE, WIDTH EXTERIOR WITH WATERCLOSET PLASTIC LAMINATE FLOOR DRAIN PLMB PLY PNL PMR WD W/O FIG FIN PLUMBING WOOD FOUNDATION WITHOUT FIGURE PLYWOOD WATERPROOFING FINISH PANEL FLRG FLOOR PROTECTED MEMBRANE ROOF FLOUR FLOORING PREFABRICATED FLUORESCENT PREFAB FTG **FEET FOOTING** PROJ PROJECT, PROJECTION

#### CONSTRUCTION NOTES

- 1. THE G.C. IS RESPONSIBLE FOR PAYING ALL FEES AND SECURING PERMITS FROM ALL AGENCIES HAVING JURISDICTION AND PROVIDING SATISFACTORY PROOF OF INSURANCE TO THE OWNER PRICE TO COMMERCING CONSTRUCTION. AT THE COMPLETION HE SHALL SEE THAT THE PROJECT IS SIGNED OFF IN THE DEPARTMENT OF BUILDING.
- 2. ALL WORK SHALL CONFORM TO THE LATEST EDITION OF ALL STATE BUILDING, PLUMBING, ELECTRIC, AND ADA CODES. THE WORK SHALL CONFORM TO ALL APPLICABLE REGULATIONS AND THE CURRENT TOWN OF \_\_\_\_\_\_ZONING BYLAWS.
- 3. ALL EXITS SHALL BE KEPT READILY ACCESSIBLE AND UNOBSTRUCTED AT ALL TIMES. REQUIRED EMERGENCY EGRESS MUST BE MAINTAINED DURING CONSTRUCTION.
- 4. ALL DOCUMENTS ARCHITECTURAL AND ENGINEERING ARE BINDING AND SHOULD BE ISSUED TO ALL SUBS ANY DISCREPANCY SHOULD BE BROUGHT TO THE ARCHITECTS DIRECTION BEFORE THE BID IS COMPLETE.
- 5. CONTRACTOR TO VISIT SITE PRIOR TO PRICING AND VERIFY ALL DIMENSIONS AND FIELD CONDITIONS. ALL CONFLICTS, ITEMS FOR CLASHICATION, AND DAMAGED EXISTING BASE BUILDING SHALL BE BROUGHT TO THE ATTENTION OF THE ARCHITECT PRIOR TO PROCEEDING WITH WORK IN THAT AREA.
- 6. THE DRAWINGS DEPICT ONLY GENERALLY THE EXISTING CONDITIONS. THE CONTRACTOR SHALL BE RESPONSIBLE FOR VERIFYING AND COORDINATING ALL DIMENSIONS AND FOR EXACT QUANTITY TAKE-OFFS BASED ON FIELD OBSERVATIONS
- 7, THE CONTRACTOR SHALL MAINTAIN COMPLETE AND UP-TO-DATE DRAWINGS AT THE JOB SITE.
- 8. ALL COAT CLOSETS SHALL HAVE ROD AND SHELF, AND CONFORM TO ALL MASS. STATE AND ADA REQUIREMENTS.
- 9. THE INTENTION OF THE CONTRACT DOCUMENTS IS TO INCLUDE ALL LABOR, MATERIALS, EQUIPMENT AND ALL OTHER ITEMS NECESSARY FOR THE PROPER EXECUTION AND COMPLETION OF THE WORK.
- 10. THE ARCHITECT WILL HAVE AUTHORITY TO REJECT WORK WHICH DOES NOT CONFORM TO THE CONTRACT DOCUMENTS AND THE CONTRACTOR SHALL REMOVE AND EXECUTE ALL UNSATISFACTORY WORK AT NO ADDITIONAL COST TO THE OWNER.
- 11. WHERE CONCEALED WOOD BLOCKING OR FRAME IS REQUIRED, CONTRACTOR SHALL USE FIRE-RETARDANT TREATED WOOD AS NEEDED.
- 12. GENERAL CONTRACTOR SHALL COORDINATE THE LOCATION OF REQUIRED BLOCKING IN WALLS TO RECEIVE WALL HUNG TV'S, CABINETS, SHELVING, MAJOR ART WORK, COAT ROD, SHELVES, TOWEL BARS AND TOILET PAPER HOLDERS.
- 13, ALL PLAN DIMENSIONS INDICATED ARE TO FINISHED FACE OF PARTITION; UNLESS OTHERWISE NOTED. DRAWINGS SHALL NOT BE SCALED TO OBTAIN DIMENSIONS.
- 14, WHERE FIRE-RATED AND FULL HEIGHT PARTITIONS ARE PENETRATED BY STRUCTURAL MEMBERS, DUCTWORK, PIPING, AND CONDUIT, THE GYPSUM BOARD SHALL BE SCRIBED TO FIT TIGHT AGAINST THE PENETRATING TEM AND CAULKED WITH THE APPROPRIATE SEALANT, OR CONSTRUCTED OTHERWISE TO PROVIDE A U.L. APPROVED ASSEMBLY DETAIL APPROPRIATE TO THE CONDITION. COORDINATE WITH MECHANICAL AND ELECTRICAL WORK AND DETAILS.
- 15. CONTRACTOR SHALL PROPERLY SHORE, UNDERPIN, AND MAKE SAFE ALL FLOORS, WALLS, SIDEWALKS, FLOORINGS, FOUNDATIONS, AND ADJACENT STRUCTURES.
- 18, ANY EXISTING PARTITIONS OR CORE WALLS INDICATED TO REMAIN, WHICH ARE DAMAGED DURING THE CONSTRUCTION OF NEW TENANT WORK, SHALL BE PATCHED AND REPAIRED BY THE CONTRACTOR TO MATCH ORIGINAL CONDITIONS. THE CONTRACTOR SHALL UNCONDITIONALLY QUARANTEE ALL MATERIALS AND WORKMANSHIP FROM THE DATE OF ACCEPTANCE AND SHALL REPLACE ANY DEFECTIVE WORK WITHIN THAT PERIOD WITHOUT EXPENSES TO THE OWNER AND PAY FOR ALL DAMAGES TO OTHER PARTS OF THE BULDING CAUSED BY REPAIR OF HIS WORK.
- 17. THE G.C. SHALL BE RESPONSIBLE TO INSTALL ANY MISSING GWB ON PERIMETER ABOVE & BELOW WINDOWS AND ALL COLUMNS.
- 18. ALL EXPOSED STRUCTURAL STEEL WHICH REQUIRES FIRE RATING SHALL BE FIREPROOFED.
- 19. THE G.C. SHALL COORDINATE WITH THE DRYWALL SUB FOR PATCHING OF EXISTING PARTITIONS, SOFFITS, COLUMNS, CORE AND PERIMETER. REPLACE DRYWALL AS NEEDED WHERE OLD WALL COVERING EXISTS, FINISH AS PER FINISH SCHEDULE.
- 20. THE G.C. SHALL COORDINATE WITH DOOR AND GWB SUBS FOR FIT OF NEW FRAMES AT PARTITIONS SO NO GAFS OCCUR. SEE DOOR SCHEDULE FOR FRAME SPECIFICATION FOLLOW ALL MANUFACTURER GUIDELINES FOR INSTALLATION AND TOLERANCE.
- 21. PROVIDE TEMPERED GLASS IN ALL AREAS AS REQUIRED BY MA BUILDING CODE.
- 22. WHERE APPLICABLE, PROVIDE A MEMBRANE WATERPROOFING (WP) UNDER ALL SHOWER AREAS: SCHLUTER KERDI SYSTEM OR APPROVED EQUIVALENT.
- 23, IT IS THE RESPONSIBILITY OF THE G.C. TO MAKE SURE ALL SUBS RECEIVE ALL DRAWINGS ARCHITECTURE AND ENGINEERING FOR PRICING AND COORDINATION.
- 24. THE CONTRACTOR AT ALL TIMES SHALL KEEP PREMISES FREE FROM ACCUMULATION OF WASTE MATERIALS OR RUBBISH CAUSED BY HIS OPERATIONS.
- 25. THE CONTRACTOR SHALL INDEMNIFY AND HOLD HARMLESS THE OWNER, THE DESIGNER AND THEIR AGENTS AND EMPLOYEES FROM AND AGAINST ANY CLAIMS, DAMAGES, LOSSES AND EXPENSES INCLUDING ATTORNEY'S FEES ARISING OUT OF OR RESULTING FROM THE PERFORMANCES OF THE WORK.
- 26, THE OWNER RESERVES THE RIGHT TO AWARD OTHER CONTRACTS IN CONNECTION WITH OTHER PORTIONS OF THE PROJECT, GENERAL CONTRACTOR IS TO COORDINATE HIS WORK WITH THE WORK OF OTHERS.
- 27. WEATHER PROTECTION: THE CONTRACTOR SHALL AT ALL TIMES PROVIDE PROTECTION AGAINST THE RAIN, WIND, STORM, FROST, OR HEAT SO AS TO MAINTAIN ALL WORK MATERIALS, APPARATUS AND FIXTURES FROM INJURY OR DAMAGE.
- 28. EACH CONTRACTOR SHALL PERFORM ALL REQUIRED CUTTING AND CHOPPING FOR HIS OWN TRADE, UNLESS OTHERWISE NOTED.
- 29. ALL NEW MATERIALS TO MATCH MATERIALS IN QUALITY, COLOR, AND TEXTURE, WHERE NEW MATERIALS ARE CONTIGUOUS WITH EXISTING.
- 30, THE CONTRACTOR SHALL BE RESPONSIBLE FOR COORDINATION WITH ALL WORK FURNISHED BY THE OWNER (FBO).
- 31. ALL WINDOWS TO BE JELDWEN PREMIUM WOOD SITELINE EX WINDOWS, PELLA ARCHITECT SERIES OR APPROVED ALTERNATIVE.
- 32. ALL INTERIOR TRIM SHALL BE CLEAR POPLAR, UNLESS OTHERWISE NOTED.
- 33. ALL EXTERIOR TRIM SHALL BE AZEK VINYL TRIM
- 34. THE GENERAL CONTRACTOR IS RESPONSIBLE FOR INSTALLING AND VENTING ALL APPLIANCES PER THE MANUFACTURER'S SPECIFICATIONS.
- 35. ALL INSULATION TO BE ICYNENE OPEN CELL FOAM INSULATION UNLESS OTHERWISE NOTED.
- 36, THE CONTRACTOR SHALL ENSURE ALL SMOKE AND CARBON MONOXIDE DETECTORS TO BE IN ACCORDANCE WITH MASS STATE FIRE CODE AND APPROVED BY LOCAL FIRE INSPECTOR PRIOR TO INSTALLATION.

RE

ADDENDUM / BULLETINS

NOT FOR CONSTRUCTION

STAMP

**GENERAL NOTES** 

THIS DOCUMENT IS THE SOLE PROPERTY OF PREMACHETICAT AND POR THE USE BY THE OWNER FOR THE SPECIFIED PROJECT, USE OF THIS DOCUMENT FOR OTHER PROJECTS OR COMMETTING OF THE PROJECT WITHOUT COMMETTING OF THE PROJECT WITHOUT COMMETTING OF THE PROJECT WITHOUT POREIDED NO LABELED AS CONSTRUCTION UNLESS STAMPED AND LABELED AS CONSTRUCTION COCCUMENTS, ALL ZIMMESSIONS TO BE VERIFIED.

PROJECT	NEW DECK
ADDRESS	13 OLD LITTLETON RD, HARVARD, MA 01451
PROJECT NUMB	ER 2021.014

2021.014	DRAWN BY	тв	CHECKED BY	до	
RD, HARVARD, MA 01451	DATE			07/19/21	
NEW DECK	PHASE			STATUS	1

A001

#### 13 OLD LITTLETON ZONING REVIEW:

AR & HARVARD COMMON HISTORIC DISTRICT ZONING CLASSIFICATION:

LOT SIZE STANDARDS:

LAND AREA OF AT LEAST 1.5 ACRES LOT WIDTH OF AT LEAST 200 FEET AT 1.20 FEET FROM THE ROADWAY CENTERLINE ACCESS FRONTAGE OF AT LEAST 100 FEET

LOT SETBACKS:


SETBACK FROM STREET 75 FEET FROM CENTERLINE SETBACK FROM NEIGHBORS 40 FEET




Zoning Classification: AR & Harvard Common Historic District Scale 1" = 30'

I certify that the existing house and proposed deck are located on the lot as shown. I further certify that the existing house and proposed deck are located within Flood Zone "X" (unshaded) per Flood Insurance Rate Map (FIRM) for the Town of Harvard, Community Panel No.25027 C0314E dated June 4, 2011.

REFERENCES: Job #33825, #33657, NB 830-26, S-15035

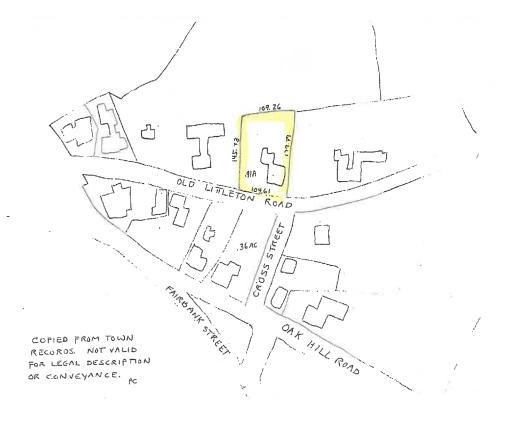

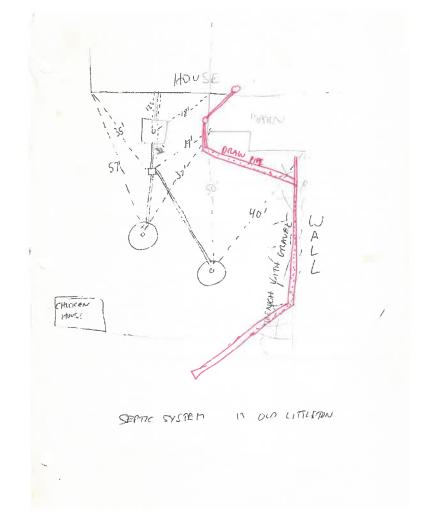

ADDENDUM / BULLETINS

[RE]Architect 30 Main St Ayer, MA 01432 P: 508-340-1210

RE


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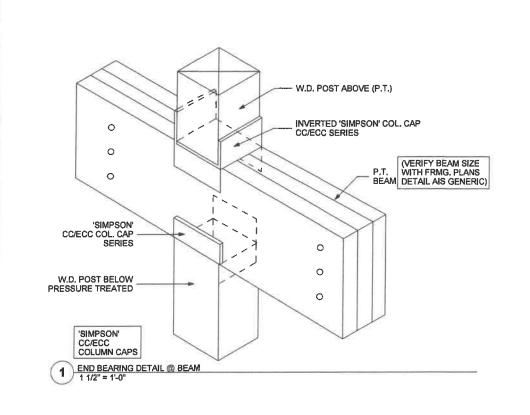
SITE PLAN


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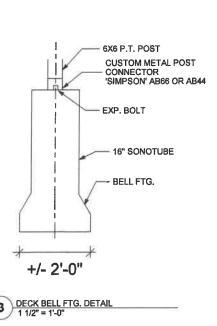
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IA 01451	DATE			07/19/21	Ī
2021.014	DRAWN BY	TG	CHECKED BY	AD	


1/4" = 1'-0" SCALE: A020





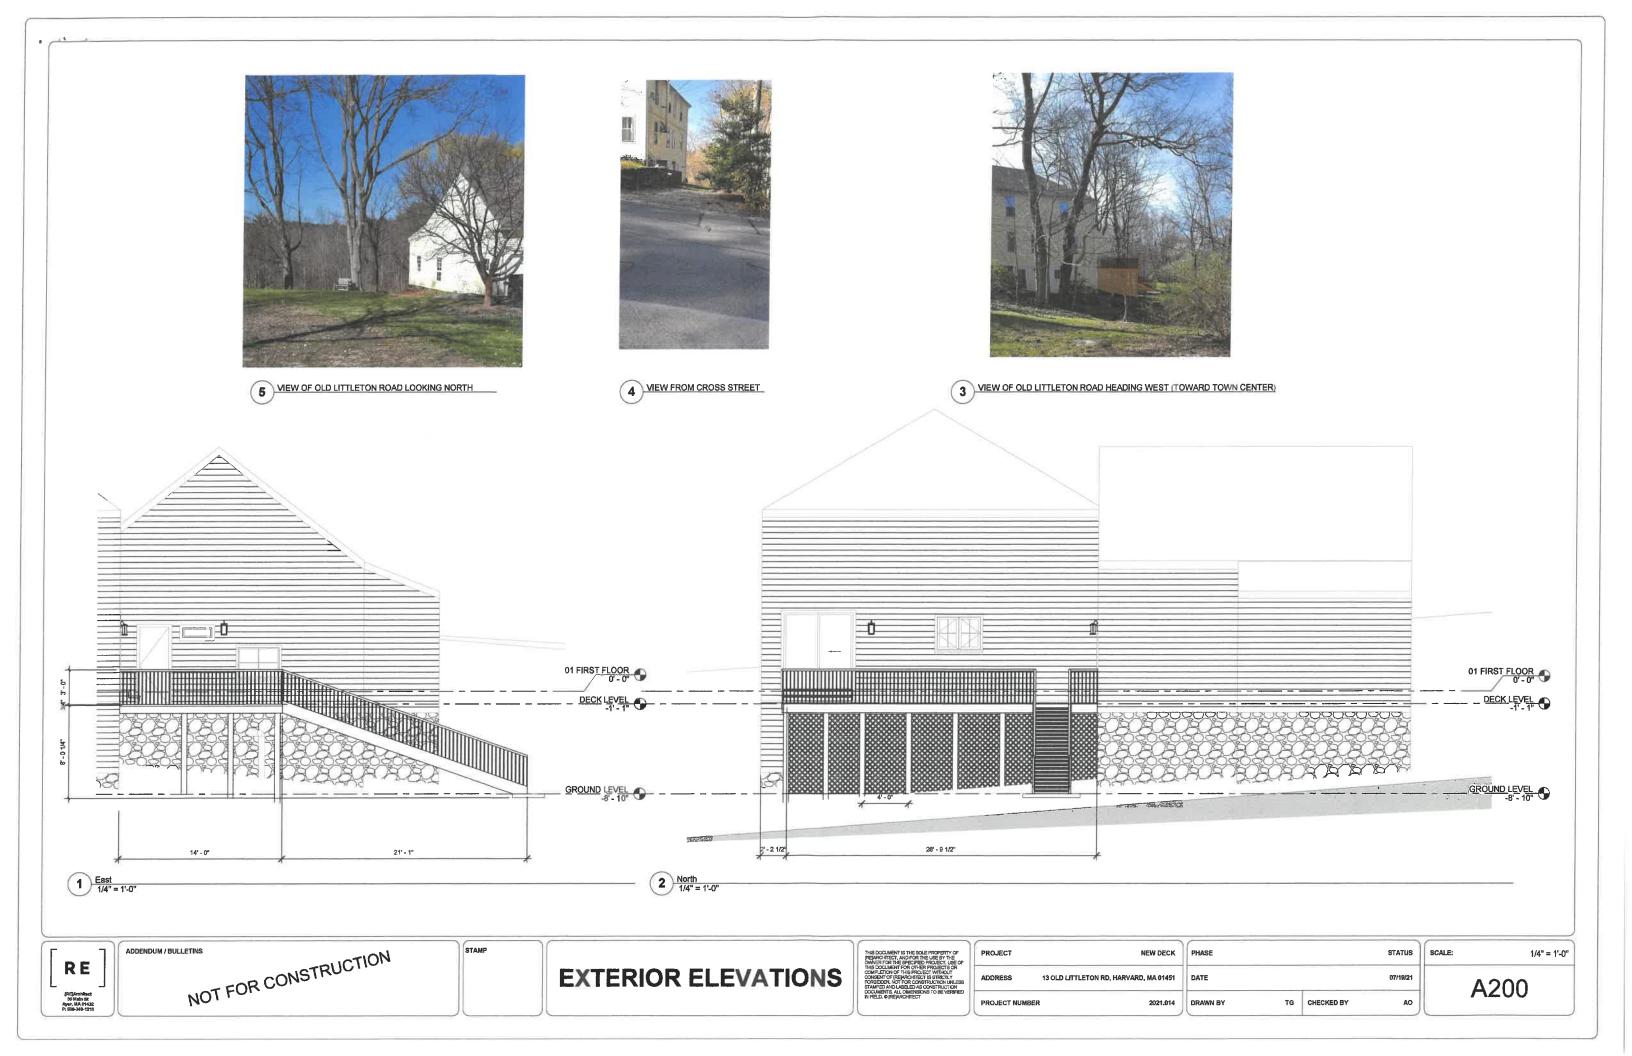

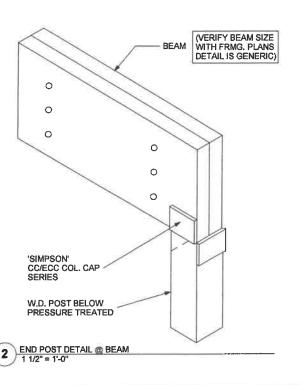

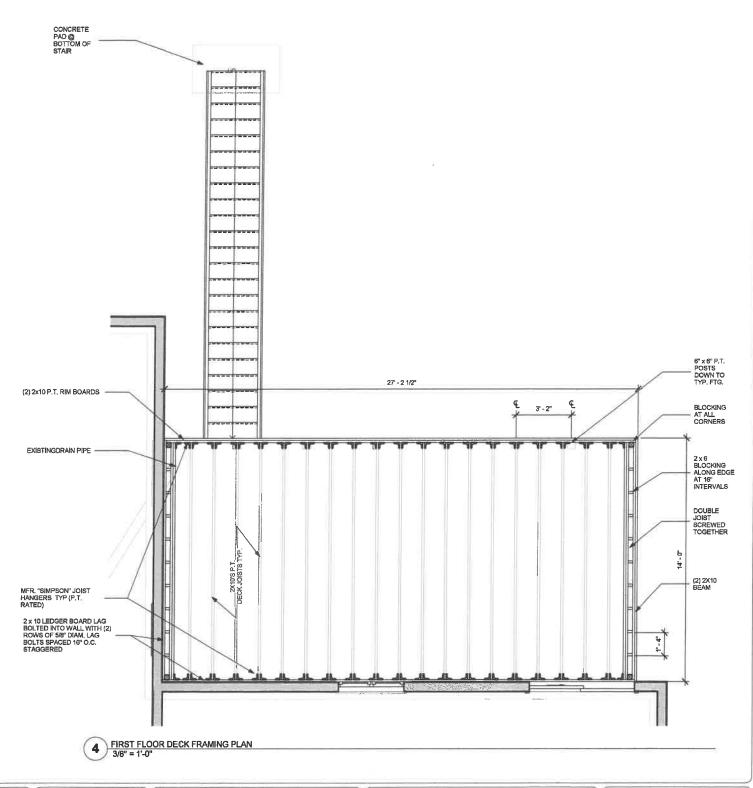



ADDENDUM / BULLETINS

NOT FOR CONSTRUCTION

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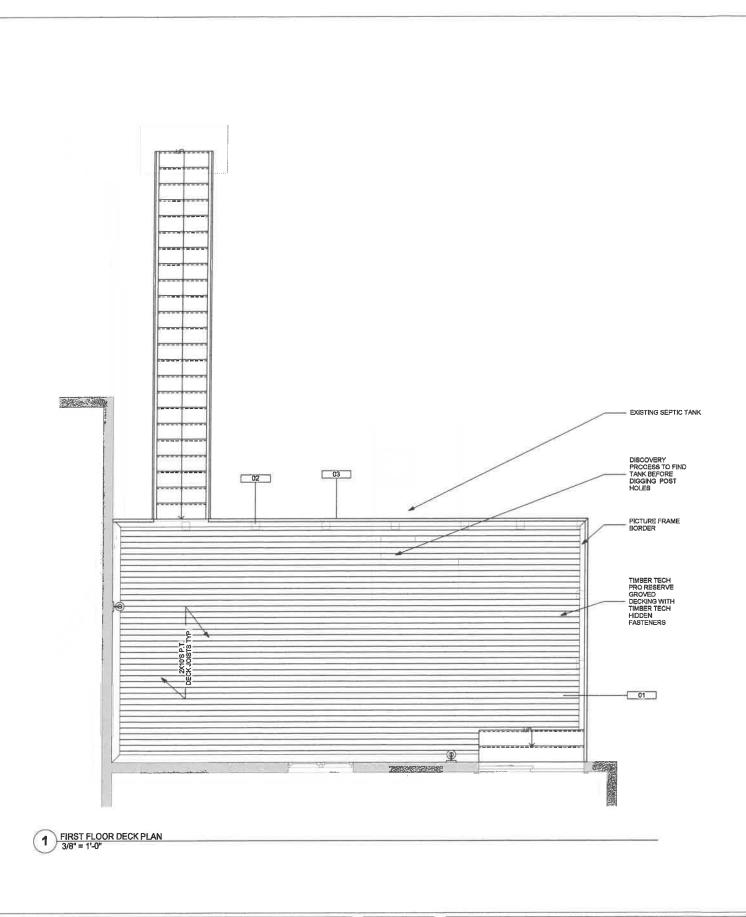
FRAMING PLANS AND DETAILS




PROJECT	NEW DECK
ADDRESS	13 OLD LITTLETON RD, HARVARD, MA 01451
DDD # 07 14114	men

DRAWN BY	TG	CHECKED BY	AO	
DATE			07/08/21	
PHASE			STATUS	so

As indicated As Indicated



	Material Schedule					
Material: Keynote	Material: Name	Material: Model	Material: Comments	Material: URL	Material: Image	
01	Wood - Flooring	TimberTech PRO Reserve Collection	Antique Leather	https://www.timbertech.com/product/pro-reserve-collection/?attribute_pa_color=antique-leather		
02	Softwood, Lumber					
03	Composit e Decking	TimberTech	TDB			

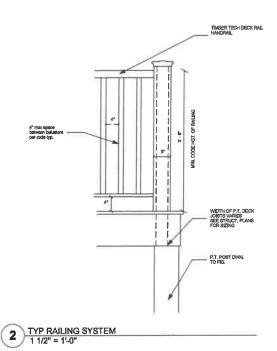

RE

[RE]Architect 30 Main St Ayer, MA 01432 P: 508-340-1210 NOT FOR CONSTRUCTION

DECK PLANS & DETAILS



	PROJECT	NEW DECK	
	ADDRESS	13 OLD LITTLETON RD, HARVARD, MA 01451	
Ì	PROJECT NUMB	ER 2021.014	1

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DATE			07/08/21	
DRAWN BY	TG	CHECKED BY	AO	

SCALE:	As indicated
Α	410



## Reserve 4-Sided Capped Composite ollection















### Inspiring. Authentic. Reclaimed.

inspired by rough wire-brushed, reclaimed wood. of 3-4 earthy hues with a matte finish. Plus, the collection's classic cathedral wood grain pattern is category. Boards in this collection boast a blend no wood for best fade and stain resistance in its four on-trend colors. The 4-sided cap contains slip-resistant decking collection that comes in Bold and multi-tonal, the NEW TimberTech® PRO™ Reserve Collection is a more durable and

- into the grooves Wood and resin composite core protected by a 4-sided cap covering the backside and
- The cap does not contain wood particles, making it more mold-resistant than the competition
- stave off mold- and moisture-damage Proprietary Mold Guard™ Technology to
- accommodate modern homeowner preferences Two on-trend gray shades available to



	RESERVE COLLECTION	TRANSCEND COLLECTION
PROTECTIVE CAP	4-sided capped composite material with Mold Guard <sup>m</sup> Technology	<b>3-sided capped</b> composite material
COMPOSITION: CAP	100% synthetic. No wood or mineral fillers	Mix of mineral fillers and composite materials
PRODUCT WARRANTY	30-Year Product Warranty	25-Year product warranty
FADE & STAIN WARRANTY	30-Year Fade & Stain Warranty Highest fade/stain performance in 3rd party testing	25-Year fade & stain warranty Lower fade/stain performance in 3rd party testing
COLORS	4 on-trend colors including 2 grays	10 colors 5 mono and 5 variegated
NATURAL, AUTHENTIC WOOD LOOK	Multi-color design with dramatic highlights and subtle undertones recreate the complex colors found in nature	Aggressive use of bold, single colors highlights that overwhelm and dominate the look of the deck
RECYCLED CONTENT	Majority	Majority
SLIP RESISTANCE	Very good	Good/Very good
SCRATCH RESISTANCE	Very good	Very good
FASTENING	Sturdy metal fastening options for superior install integrity	Limited fastening options available often requiring larger gaps
PRICING	\$\$	\$\$\$

TREX TRANSCEND TREX TRANSCEND SPICED RUM TREX TRANSCEND HAVANA GOLD Alternative: a warmer, slightly lighter gray with brown tones



TIMBERTECH\*RESERVE DARK ROAST\*\*

TIMBERTECH®RESERVE DRIFTWOOD

TIMBERTECH®RESERVE STORM GRAY

SS\_TT\_PRO\_RESERVE

TimberTech.com

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# COMPOSITE DECKING

Display hidden notes to specifier. (Don't know how? Click Here)

## PART 1 GENERAL

## 11 SECTION INCLUDES

P Composite decking.

## 7. **RELATED SECTIONS**

⋗ Section 06-1100 - Wood Framing.

### <u>...</u> REFERENCES

- P ASTM D-1413-99: Test Method for Wood Preservatives by Laboratory Soil-block Cultures, ASTM International.
- Ü ASTM D-2565-99: Practice for Operating Xenon Arc-type Light-exposure Apparatus With or Without Water for Exposure of Plastics, ASTM International.
- 9 ASTM D-2915-98: Practice for Evaluating Allowable Properties for Grades of Structural Lumber, ASTM International.
- Ö ASTM D-2990-95: Test Method for Tensile, Compressive, and Flexural Creep and Creep-rupture of Plastics, ASTM International.
- $\Box$ ASTM D-5456-99a: Specification for Evaluation of Structural Composite Lumber ASTM D-3345-74 (1999): Test Method for Laboratory Evaluation of Wood and Other Cellulose Materials for Resistance to Termites, ASTM International.

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- Ω Products, ASTM International.
- 工 ASTM D-6109-97: Standard Test Method for Flexural Properties of Un-reinforced and Reinforced Plastic Lumber, ASTM International.
- -ASTM D-7032-04: Standard Specification for Establishing Performance Ratings for Wood-Plastic Composite Deck Boards and Guardrail systems (Guards or Handrails), ASTM D-7031-04: Standard Guide for Evaluating Mechanical and Physical Properties of Wood-Plastic Composite Products, ASTM International.
- ŗ. International. ASTM E-4-99: Practices for Force Verification of Testing Machines, ASTM ASTM International.
- ᄌ ASTM E-84-01: Test Method for Surface Burning Characteristics of Building

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Materials, ASTM International.

- ASTM E-330-97: Standard Test Method for Structural Performance of Exterior Windows, Curtain Walls, and Doors by Uniform Static Air Pressure Difference, ASTM International.
- ASTM F-1679: Standard Test Method for Using a Variable Incidence Tribometer (VIT). Š

# DESIGN / PERFORMANCE REQUIREMENTS 4.

- Structural Performance: Ä
- Deck: Uniform Load: 100 lb/sq. ft. Treads of Stairs: Concentrated Load: 750 lb/sq. ft., and 1/8" max. defection with a concentrated load of 300 lb on area of 4 sq. in
- Fire-Test-Response Characteristics per ASTM E-84:

### SUBMITTALS 1.5

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- Product Data: Indicate sizes, profiles, surface style, and performance characteristics Ä
- Samples: For each product specified, one sample, minimum size 4 inches long, representing actual product, color, and finish. œ.

## DELIVERY, STORAGE, AND HANDLING 1.6

- Storage and Handling: Ä

- Never dump TimberTech materials when unloading.
  Store on a flat surface and cover with non-translucent material.
  When carrying TimberTech planks, carry on edge for better support.
  Refer to installation instructions for additional guidelines on each product.

### WARRANTY 1,7

Warranty: Limited Residential Warranty against rot, decay, splitting, checking, splintering, or termite damage for a period of 25 years beginning from date of purchase under normal conditions of use and exposure. Ċ

### 2 PRODUCTS **PART**

## MANUFACTURERS 2.1

- Contract Documents are based on products by: TimberTech Limited, 894 Prairie Avenue, Wilmington, Ohio 45177. Ä
- Substitutions: Not permitted under Division 01 œ.

## APPLICATIONS/SCOPE 2.2

- Wood/Plastic Composite Lumber: Ä
- Material Description: Composite plank consisting of high density polyethylene (HDPE) and wood flour, extruded into sizes and shapes indicated with the following physical properties:

  ValuPlank, Earthwood, and TwinFinish Decking Boards: 1 inch x 5-7/16 -inches wide.
  - - Lengths-12, 16, and 20 feet.

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## 3.1 EXAMINATION

- . Install according to manufactures instructions.
- B. Cut, drill, and rout using carbide tipped blades.
- Pre-drill holes located closer than 1 1/2 inches from ends of plank. ပ
- D. Cut ends square.
- E. Do not use composite wood material for structural applications.

## 3.2 CLEANING

- Clean surfaces regularly with a composite wood/plastic cleaner such as Corte Clean (www.corteclean.com) . Ä
- Power wash with a fan tipped nozzle in the direction of the grain of the planks with a maximum of 1500 psi. œ.

**END OF SECTION** 

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